


MARK	COL. MEMBER	COL. CAP CONNECTION	COL. BASE CONNECTION
FA	POST ABOVE	SEE FRAMING PLAN(S)	-
1	6x6 DgFm	SEE FRAMING PLAN(S)	SEE FOUNDATION PLAN
2	4x6 DgFm	SEE FRAMING PLAN(S)	SEE FOUNDATION PLAN
3	6x6 DgFm	SIMPSON EPC66	SEE FOUNDATION PLAN
4	4x6 DgFm	SIMPSON ECC5 1/4-4	SEE FOUNDATION PLAN
5	4x6 DgFm	SIMPSON ECC46	SEE FOUNDATION PLAN
6	4x4 DgFm	SIMPSON EPC44	SEE FOUNDATION PLAN
7	4x4 DgFm	SIMPSON CC44	SEE FOUNDATION PLAN
8	4x4 DgFm (WEATHERPROOFED)	SEE FRAMING PLAN(S)	SEE FOUNDATION PLAN

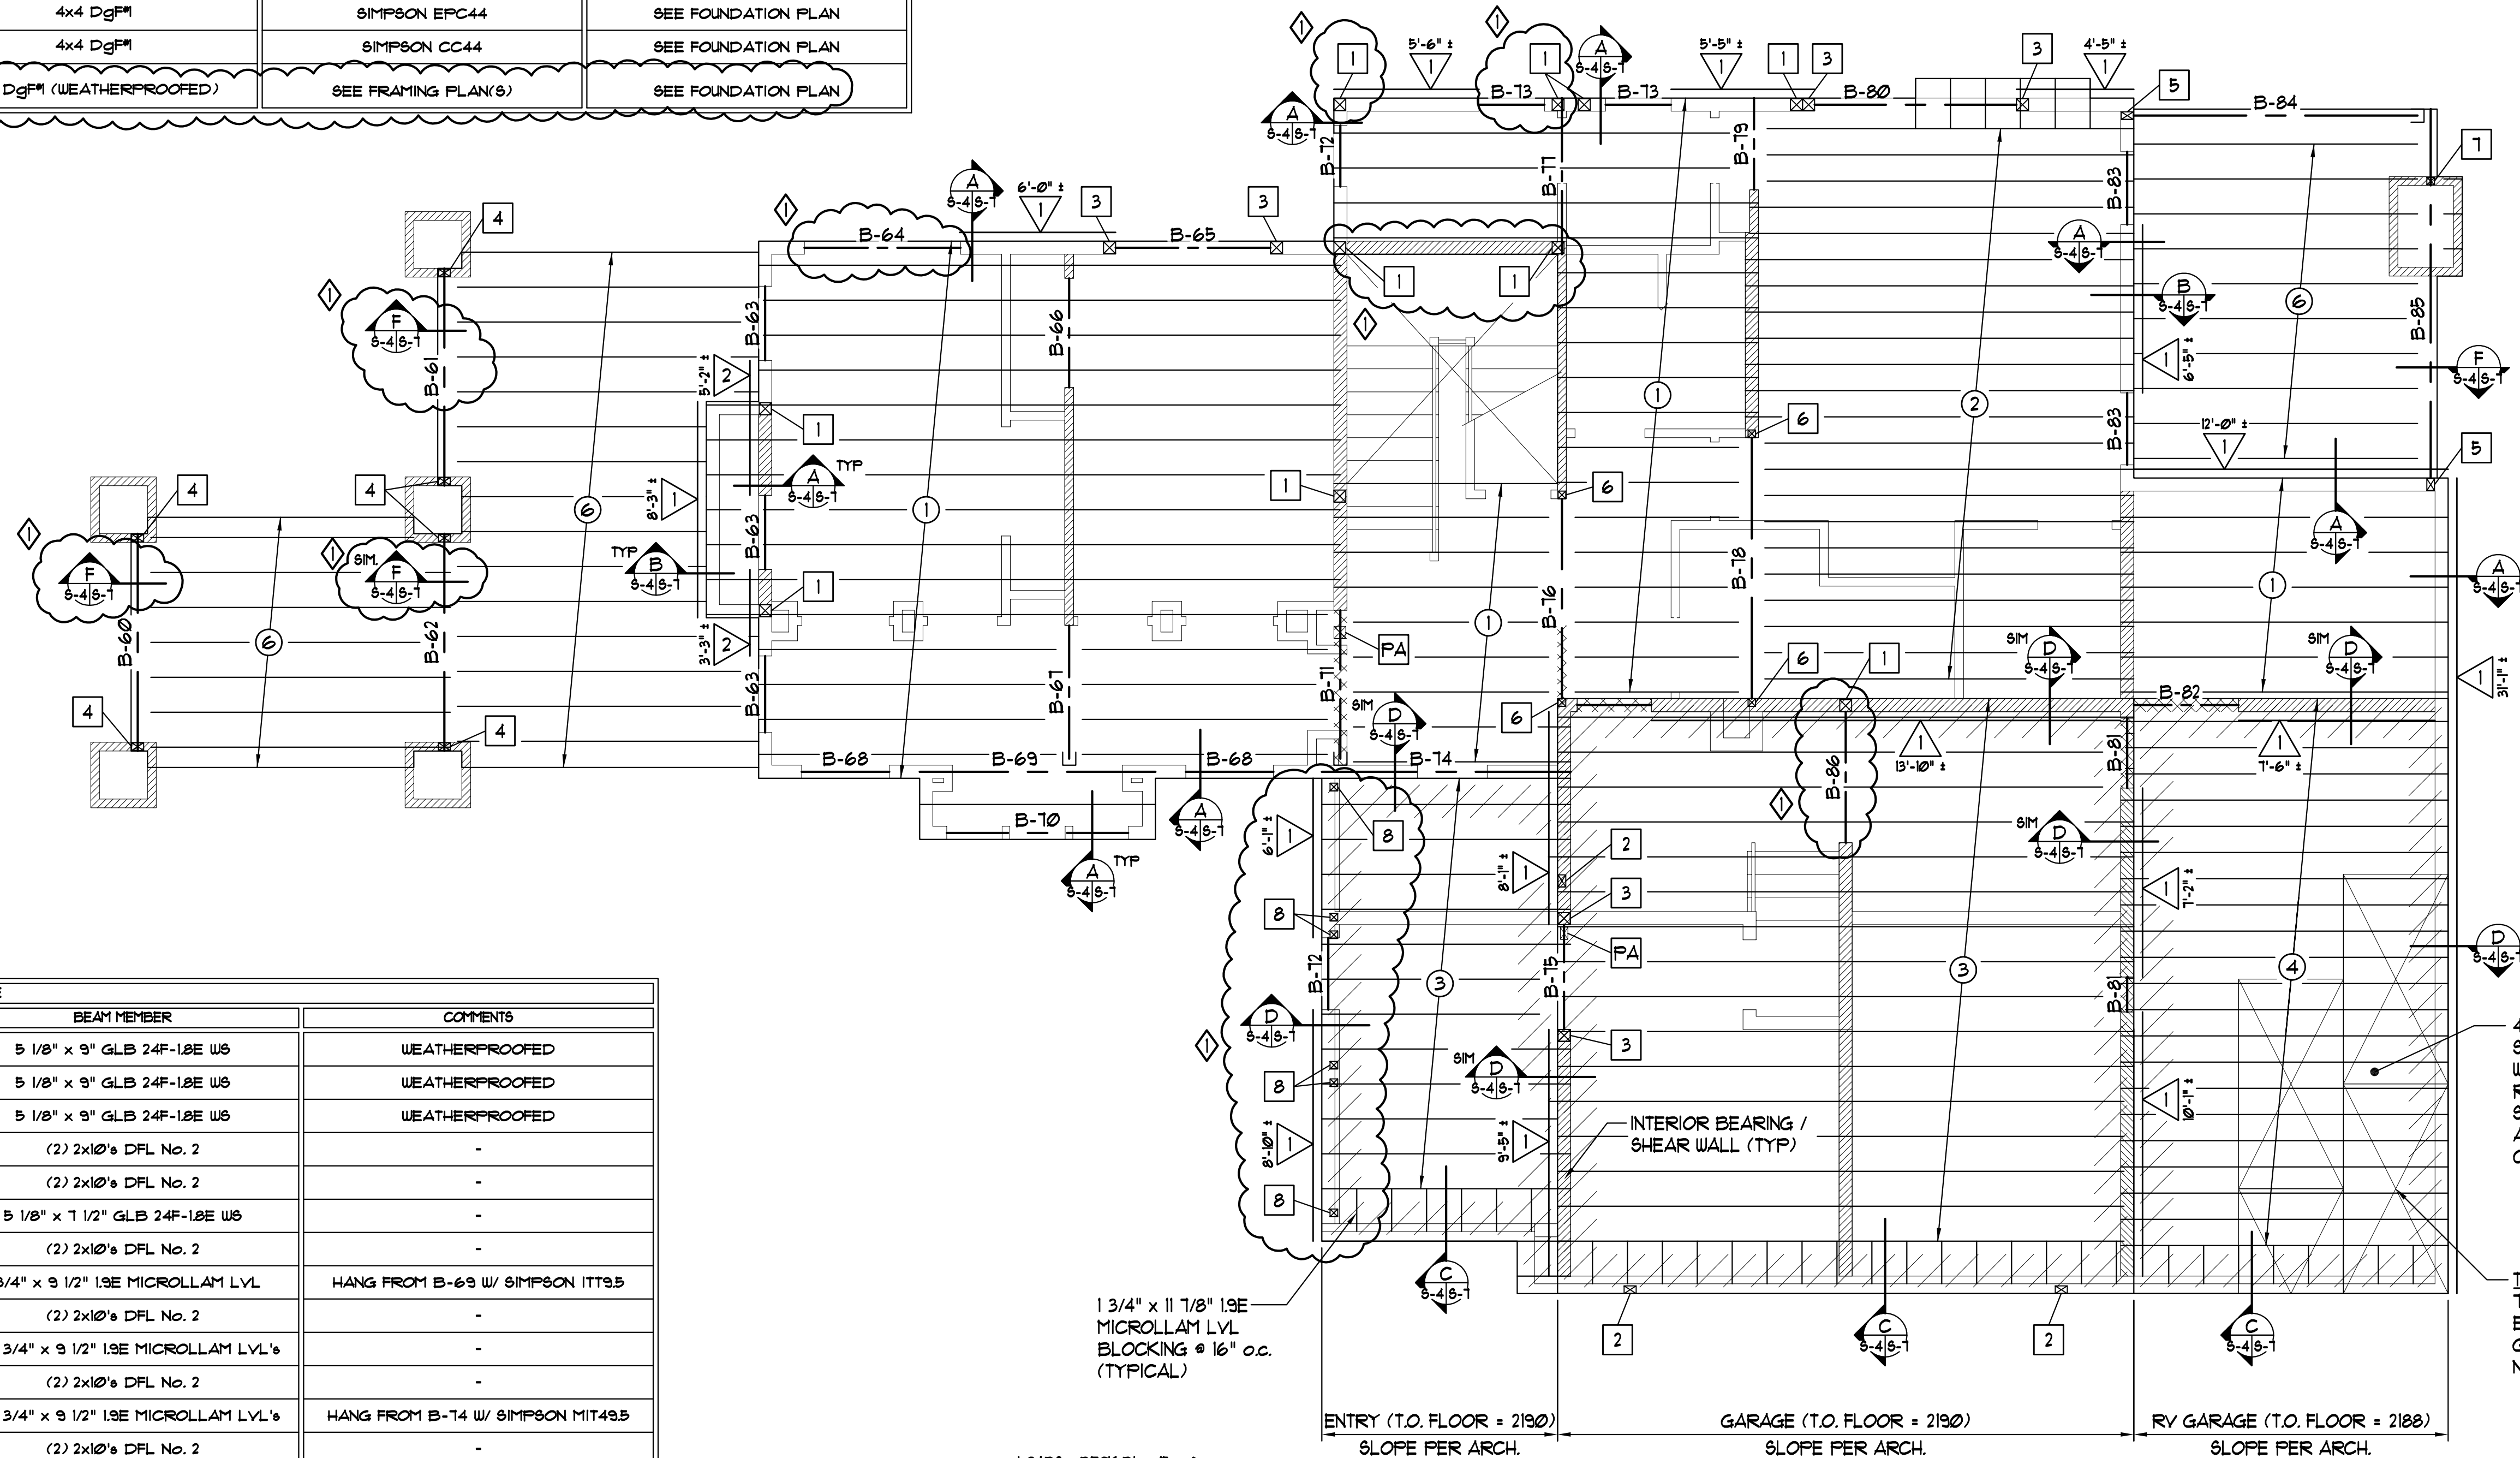

MARK	BEAM MEMBER	COMMENTS
B-60	5 1/8" x 9" GLB 24F-12E W6	WEATHERPROOFED
B-61	5 1/8" x 9" GLB 24F-12E W6	WEATHERPROOFED
B-62	5 1/8" x 9" GLB 24F-12E W6	WEATHERPROOFED
B-63	(2) 2x10's DFL No. 2	-
B-64	(2) 2x10's DFL No. 2	-
B-65	5 1/8" x 7 1/2" GLB 24F-12E W6	-
B-66	(2) 2x10's DFL No. 2	-
B-67	1 3/4" x 9 1/2" 1.9E MICROLLAM LVL	HANG FROM B-69 W/ SIMPSON ITT9.5
B-68	(2) 2x10's DFL No. 2	-
B-69	(2) 1 3/4" x 9 1/2" 1.9E MICROLLAM LVL's	-
B-70	(2) 2x10's DFL No. 2	-
B-71	(2) 1 3/4" x 9 1/2" 1.9E MICROLLAM LVL's	HANG FROM B-74 W/ SIMPSON MIT49.5
B-72	(2) 2x10's DFL No. 2	-
B-73	(2) 2x10's DFL No. 2	-
B-74	(2) 1 3/4" x 9 1/2" 1.9E MICROLLAM LVL's	-
B-75	5 1/8" x 7 1/2" GLB 24F-12E W6	-
B-76	3 1/2" x 9 1/2" 2.0E PARALLAM P8L	-
B-77	(2) 2x10's DFL No. 2	-
B-78	3 1/2" x 9 1/2" 2.0E PARALLAM P8L	-
B-79	1 3/4" x 9 1/2" 1.9E MICROLLAM LVL	-
B-80	5 1/8" x 7 1/2" GLB 24F-12E W6	-
B-81	(2) 2x10's DFL No. 2	-
B-82	1 3/4" x 11 7/8" 1.9E MICROLLAM LVL	-
B-83	(2) 2x10's DFL No. 2	-
B-84	4x10 DFL No. 2 (WEATHERPROOFED)	HANG FROM B-85 W/ SIMPSON HUCQ410
B-85	4x10 DFL No. 2 (WEATHERPROOFED)	14'-1" LONG ± (VERIFY)
B-86	(2) 2x12's DFL No. 2	-

MARK	JOIST	NOTES
1	9 1/2" TJI 210's @ 16" o.c.	HANG W/ SIMPSON ITT2.1/9.5 WHERE APPLICABLE
2	9 1/2" TJI 210's @ 12" o.c.	HANG W/ SIMPSON ITT2.1/9.5 WHERE APPLICABLE
3	1 3/4" x 11 7/8" 1.9E MICROLLAM LVL's @ 16" o.c.	-
4	1 3/4" x 11 7/8" 1.9E MICROLLAM LVL's @ 12" o.c.	-
6	2x10's DgFm @ 16" o.c. (WEATHERPROOFED)	HANG W/ SIMPSON LB210 WHERE APPLICABLE

LOADS: DECK DL = 15 psf
 FLOOR DL = 35 psf
 LL = 40 psf
 GARAGE DL = 65 psf
 GARAGE LL = 50 psf

MAIN FLOOR FRAMING PLAN (2190)
 SCALE: 1/4" = 1'-0"

- NOTES:
- △ DESIGNATES SHEAR PANELS IN ACCORDANCE W/ THE SHEAR PANEL SCHEDULE ON SHEET S-1.
 - DESIGNATES COLUMNS IN ACCORDANCE W/ THE COLUMN SCHEDULE ON THIS SHEET.
 - ⊙ DESIGNATES ROOF JOISTS IN ACCORDANCE W/ THE JOIST SCHEDULE ON THIS SHEET.
 - B-* DESIGNATES BEAM IN ACCORDANCE W/ THE BEAM SCHEDULE ON THIS SHEET.
 - BEAMS & HEADERS TO BE SUPPORTED BY DBL 2x 6TD COLUMNS MIN. UNLESS OTHERWISE NOTED.
 - SEE SHEET S-1 FOR ADDITIONAL FRAMING NOTES.



HOIT ENGINEERING
 1423 E. Lacey Ave.
 Hayden, Idaho 83835
 (208) 772-1100

COUPER RESIDENCE - GOTHAM BAY
 885 E. PINE RIDGE DRIVE - HARRISON, IDAHO

PROJ #	DATE	SCALE	DRAWN BY
080023	4/28/09	1/4" = 1'-0"	MH

MAIN FLOOR FRAMING PLAN
 S-4