



BEAM SCHEDULE		
MARK	BEAM MEMBER	COMMENTS
B-11	BEAM PER ROOF FRAMING PLAN	-
B-13	BEAM PER ROOF FRAMING PLAN	-
B-15	BEAM PER ROOF FRAMING PLAN	-
B-21	BEAM PER ROOF FRAMING PLAN	-
B-22	BEAM PER ROOF FRAMING PLAN	-
B-24	BEAM PER ROOF FRAMING PLAN	-
B-26	BEAM PER ROOF FRAMING PLAN	-
B-27	BEAM PER ROOF FRAMING PLAN	-
B-28	BEAM PER ROOF FRAMING PLAN	-
B-35	(2) 2x10's DFL No. 2	-
B-36	1 3/4" x 11 7/8" 1.9E MICROLLAM LVL	HANG W/ SIMPSON HUS181/10 (TYP)
B-37	5 1/8" x 9" GLB 24F-1.8E US	-
B-38	(2) 2x10's DFL No. 2	-
B-39	(2) 1 3/4" x 11 7/8" 1.9E MICROLLAM LVL's	-
B-40	5 1/8" x 7 1/2" GLB 24F-1.8E US	-
B-41	1 3/4" x 11 7/8" 1.9E MICROLLAM LVL	-
B-42	(2) 1 3/4" x 11 7/8" 1.9E MICROLLAM LVL's	-
B-43	1 3/4" x 11 7/8" 1.9E MICROLLAM LVL	-
B-44	1 3/4" x 11 7/8" 1.9E MICROLLAM LVL	-
B-45	(2) 2x10's DFL No. 2	-
B-46	(2) 2x10's DFL No. 2	-
B-47	(2) 2x8's DFL No. 2	HANG FROM B-48 W/ SIMPSON HUS28-2TF
B-48	4x8 DFL No. 2	HANG FROM B-50 W/ SIMPSON HUS48
B-49	(2) 2x10's DFL No. 2	-
B-50	5 1/8" x 15" GLB 24F-1.8E US	-
B-51	(2) 2x10's DFL No. 2	-
B-52	3 1/8" x 9" GLB 24F-1.8E US (WEATHERPROOFED)	-
B-53	5 1/8" x 9" GLB 24F-1.8E US x 13'-9" LONG (WEATHERPROOFED)	HANG FROM B-52 W/ SIMPSON HUCQ525/3-SDS
B-54	5 1/8" x 9" GLB 24F-1.8E US x 13'-9" LONG (WEATHERPROOFED)	HANG FROM B-52 W/ SIMPSON HUCQ525/3-SDS

COLUMN SCHEDULE			
MARK	COL. MEMBER	COL. CAP CONNECTION	COL. BASE CONNECTION
PA	POST ABOVE	SEE ROOF FRAMING PLAN	-
1	6x6 DgF#1	SEE ROOF FRAMING PLAN	SEE FOUNDATION PLAN
2	4x6 DgF#1	SEE ROOF FRAMING PLAN	SEE FOUNDATION PLAN
3	6x6 DgF#1	SIMPSON EPC66	SEE FOUNDATION PLAN
4	4x4 DgF#1 (WEATHERPROOFED)	SEE ROOF FRAMING PLAN	SEE FOUNDATION PLAN

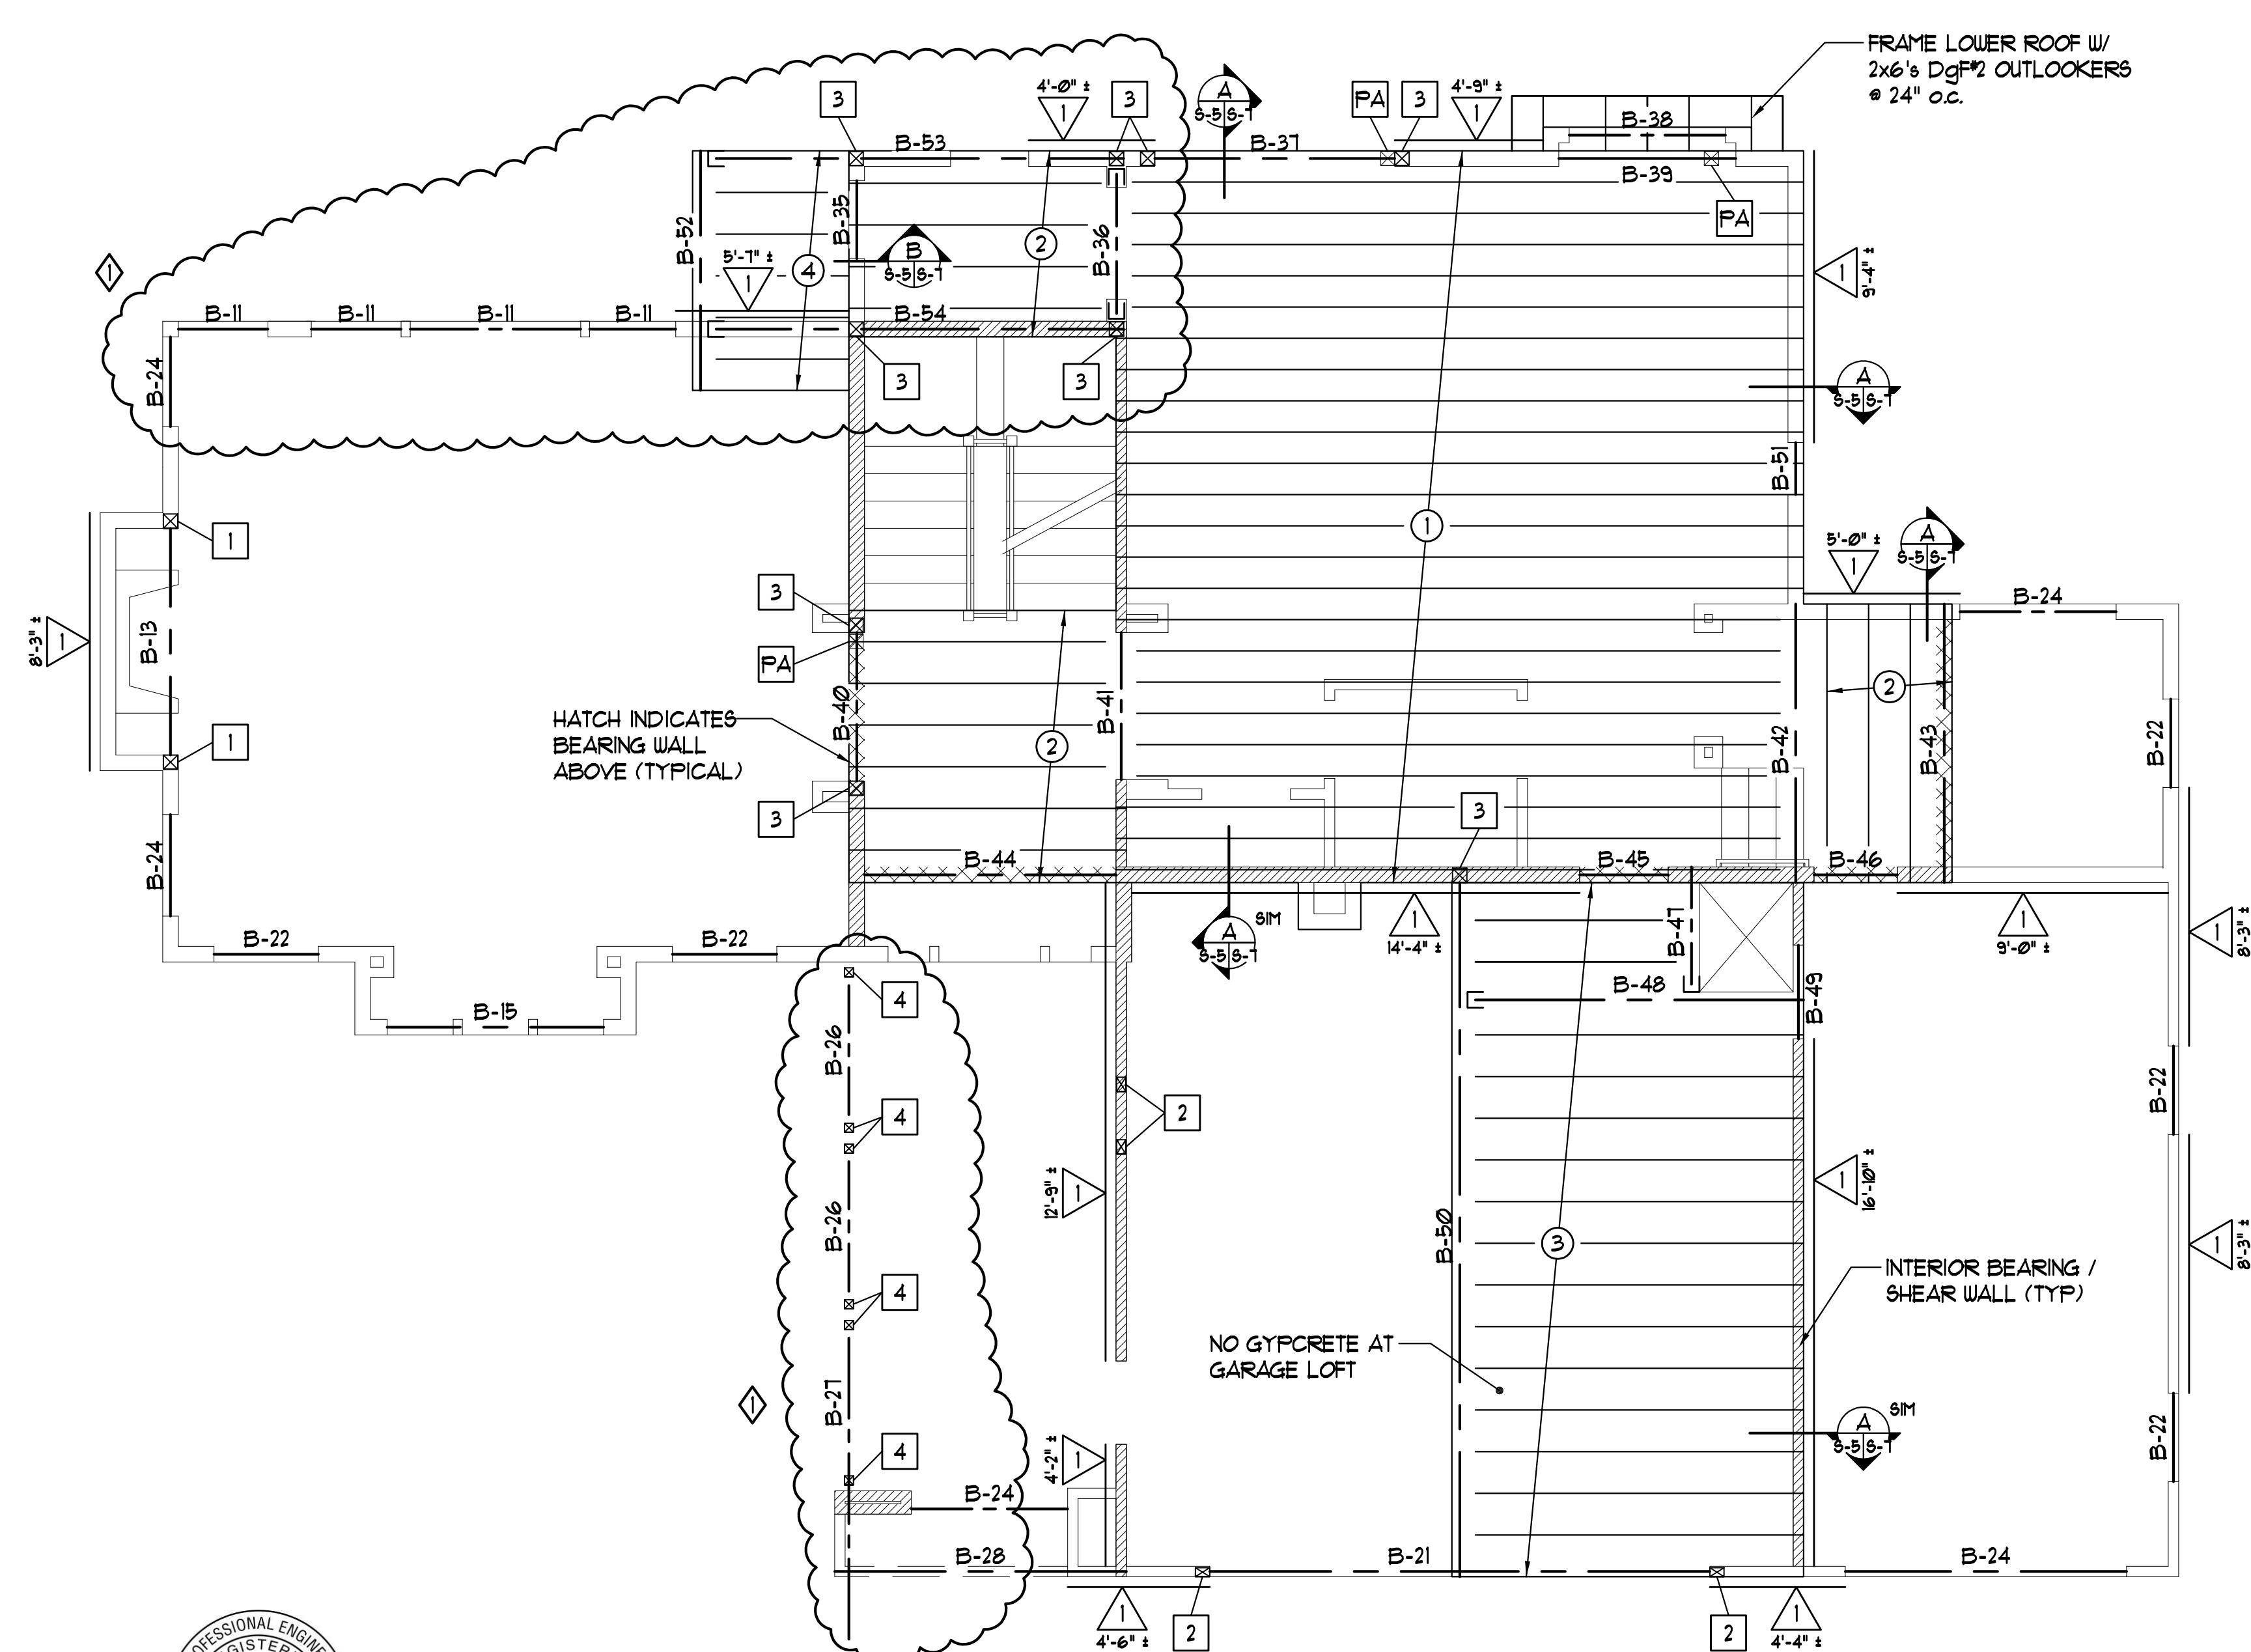

LOADS: GARAGE LOFT DL = 15 psf
 FLOOR DL = 35 psf
 LL = 40 psf

UPPER FLOOR FRAMING PLAN (2200)
 SCALE: 1/4" = 1'-0"

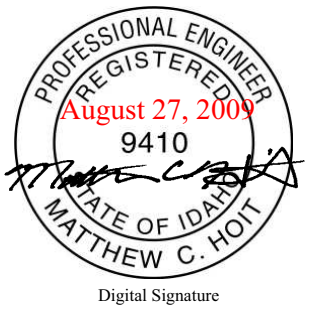

JOIST SCHEDULE		
MARK	JOIST	NOTES
1	11 7/8" TJI 560's @ 12" o.c.	HANG W/ SIMPSON ITT411.88 WHERE APPLICABLE
2	11 7/8" TJI 560's @ 16" o.c.	HANG W/ SIMPSON ITT411.88 WHERE APPLICABLE
3	2x8's DgF#2 @ 16" o.c.	HANG W/ SIMPSON U26 WHERE APPLICABLE
4	2x8's DgF#2 @ 16" o.c. (WEATHERPROOFED)	HANG W/ SIMPSON JB28 WHERE APPLICABLE

NOT USED



- NOTES:
- DESIGNATES SHEAR PANELS IN ACCORDANCE W/ THE SHEAR PANEL SCHEDULE ON SHEET S-1.
 - DESIGNATES COLUMNS IN ACCORDANCE W/ THE COLUMN SCHEDULE ON THIS SHEET.
 - DESIGNATES ROOF JOISTS IN ACCORDANCE W/ THE JOIST SCHEDULE ON THIS SHEET.
 - B-* DESIGNATES BEAM IN ACCORDANCE W/ THE BEAM SCHEDULE ON THIS SHEET.
 - BEAMS & HEADERS TO BE SUPPORTED BY DBL 2x STUD COLUMNS MIN. UNLESS OTHERWISE NOTED.
 - SEE SHEET S-1 FOR ADDITIONAL FRAMING NOTES.

HOIT ENGINEERING
 1423 E. Lacey Ave.
 Hayden, Idaho 83835
 (208) 772-1100

COWPER RESIDENCE
 865 E. PINE RIDGE DRIVE - GOTHAM BAY
 HARRISON, IDAHO

UPPER FLOOR FRAMING PLAN			
PROJ #	DATE	SCALE	DRAWN BY
080023	4/10/09	1/4" = 1'-0"	MH

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